### SOUTH DAKOTA DEPARTMENT OF TRANSPORTATION APPLICATION FOR PERMIT TO OCCUPY RIGHT OF WAY

Highway No. 45 Co	ounty HAND	✓ Approximately 7	Miles N 🖾 S 🗍 E 🗍 W 🗍
From (City or well defined poin	) Miller		
Description and Purpose of occ	upancy: F	Renewable energy infrastructure deline Temporary intersection modification/	
October 31st, 2023			timated date of removal or completion:
I, the undersigned, request per sheet. In consideration for this	mission to occu permission, I ag	py public right-of-way at the above lo ree to abide by all conditions as her	ocation and as shown on the attached layou ein stated.
damage to the roadway this permit. 2. To provide protection to as prescribed in the "Ma 3. To indemnify and hold th hamless from and again	and right-of-way highway traffic of nual of Uniform he State of South hist any and all a injuries or dama hy designated in nt)	y to equal or better conditions than e during occupancy by the use of prop Traffic Control Devices." In Dakota, its Department of Transpo loctions, suits, damages, liability or ot age received or sustained by any pe	e occupancy including restoration of any existed prior to the occupancy covered by er signs, barricades, flagpersons and lights ortation, its officers, agents and employees, ther proceedings of any kind or nature rson or property on account of the use or DATE $Abh. 15$ $2022$
	(Name of Ind	lividual, Company, Organization, etc	
EMAIL ADDRESS Ibell@scout	cleanenergy.cor	n	
Project (Const.) Project (Maint.)045-192	Station/N	eted by Department of Transportation*** /ilepost104.245Ma	intenance Unit
<ol> <li>Prior to commencing occupa at <u>Huron Area Off</u></li> <li>Special Conditions <u>The n</u></li> </ol>	ice iodifications sh d Plates. The m		Roger Flint 140 vith Special Conditions Sheet, attached ater than June 1, 2023 without prior - August 1, 2023

3. Failure to accomplish the occupancy in accordance with the provisions of this permit will automatically render this permit null and void and where applicable, constitute grounds for its removal and/or full restoration of the occupancy site all at the applicant's expense.

This permit to occupy the right-of-way is granted to all conditions as herein stated on this \_\_\_\_\_ day of \_\_\_\_\_, 20\_22

Area Engineer

Chief Bridge Engineer (Bridge Installations only)

#### **INSTRUCTIONS FOR DOT-295**

#### APPLICANT:

- 1. Complete all items at the top of the form.
- 2. If the occupancy involves work within the right-of-way, prepare a separate sheet showing the work to be accomplished. The drawing should include:
  - Width of the highway from shoulder to shoulder
  - Width of the right-of-way
  - · Details of the work to be performed by the occupancy
  - A North arrow
  - Installations on bridges must include details of the method(s) of attachment.
  - Any other pertinent information
- 3. Sign the form and submit it and any attachments to the Region Office for processing.

#### DEPARTMENT OF TRANSPORTATION REGION OFFICE:

- 1. Complete the bottom portion of the form.
- 2. Installations involving bridges require review/approval of the Chief Bridge Engineer. If review by the Office of Bridge Design is necessary, allow two weeks for review.
- 3. If the request is denied, return the request to the applicant and state the reason for denial.
- 4. If the request is granted, make and send copies of the permit and attachments to:
  - Applicant
    - Area Engineer
    - Maintenance Supervisor
  - Chief Bridge Engineer (if applicable)
- 5. File the original copy in the Region Office.

NOTE: After Region Engineer (and Chief Bridge Engineer if necessary) approval, requests on Interstate Highways are to be forwarded to the Office of Right-of-Way to obtain the concurrence of the FHWA. Data will be returned to the Region Office for distribution.

### Special Conditions Attachment Sheet

The items listed below are a summary of requirements set by the SDDOT for work being done within the ROW. It shall be the permit holder's responsibility to acquire the information needed to complete work as per the SDDOT Standard Specifications for Roads and Bridges 2015 Edition. Included is a link to the SDDOT standard plates for reference to situations. <u>http://sddot.com/business/design/plates/index/Default.aspx</u>. For instances where uncertainty exists, questions should be referred to the Huron Area SDDOT.

- Traffic control shall be in accordance with the Manual on Uniform Traffic Control Devices. (MUTCD) or SDDOT standard plates for traffic control devices.
- Salvage and replace topsoil. No piles can be left within the ROW. Topsoil removed shall be placed on the widened area slopes. It will then be salvaged before removal of the widening material so it can be placed on the final inslopes of the Highway.
- 3. All pavement markings removed or damaged by the contractor shall be replaced to the satisfaction of the DOT.
- 4. Any subsequent damage to the roadway, shoulder or other items within the ROW, due to construction activities will be repaired by applicant at no cost to the state.
- No obstructions shall be placed within the ROW without prior acceptance by the SDDOT.
- Erosion Control measures shall be utilized as per the State, Federal, County and City regulations. Erosion control and sediment control is the sole responsibility of the Permit holder.
- 7. All signage that is removed to allow a delivery must be replaced **immediately** after each delivery goes through the intersection.
- The pipe shall be extended so the flowline is level with the existing ditch bottom. If longer slopes are used, the pipe length will be adjusted accordingly. The slopes shall be a minimum 6:1 as per Standard Plate 120.01.
- 9. Drainage must be maintained around the corner from 205th to SD 45 at all times. This may require an additional pipe or ditch shaping.
- 10. The applicant is responsible for construction and maintenance of the widened area, including erosion repair and snow removal, if applicable.
- 11. Signage or landscaping shall not be placed in or overhang the Right-Of-Way. Items placed outside the Right-Of-Way shall not block the view of oncoming traffic.
- 12. All disturbed areas shall be re-established as per the re-vegetation Plan for Disturbed State Owned Right-of-Way. (As shown below)

#### Re-vegetation Plan for Disturbed State Owned Right of Way

#### Shaping:

All disturbed, areas are to be re-topsoiled and leveled to promote vegetative growth and to remove any obstructions of drainage.

### Special Conditions Attachment Sheet

#### Seeding:

All disturbed areas will be stabilized within 14 days of the completion of earthmoving work. Seed mixture is to consist of the following:

Western Wheatgrass	7lbs of pure live seed
Green Needlegrass	4lbs of pure live seed
Sideoats Grama Blue	3lbs of pure live seed
Grama	2lbs of pure live seed
(Oats from April to July, Winter Wheat August to November)	10lbs of pure live seed

Overall

26lbs pure live seed per acre

Mulch is to be applied to the disturbed area at a rate of 2 tons per acre. Mulch is to be free of any and all noxious weeds.

Mulch is not required if disturbed area is less than 0.5 acres.

Commercial fertilizer with a guaranteed analysis of 18-46-0 is to be applied at a rate of 100lbs per acre.


#### Sediment and Erosion Control.


Usage of Best Management Practices for sediment and erosion control is mandatory. Applicant is duly reminded that if over 0.5 acres will be disturbed, applicant must have on hand an approved Notice of Intent from the Department of Environment and Natural Resources as well as a full Storm Water Pollution Prevention Plan. (SWPPP) Both of these documents are the applicant's responsibility to attain. Once vegetation is reestablished, the applicant is duly reminded that a Notice of Termination is also needed to be sent to the Department of Environment and Natural Resources. Protective devices are to be installed prior to disturbing State Right of Way to prevent erosion from damaging the environment. More information can be found at the below web link.

http://www.sddot.com/business/environmental/stormwater/Default.aspx

#### **Final Inspection**

The permittee is required to conduct an inspection of the installation area approximately 10 to 12 months after installation to ensure no erosion has occurred and that no settlement areas exist. Any areas found are to be repaired in accordance with the above notes. Area is also to be inspected for noxious weed. If noxious weeds are found, they are to be sprayed and destroyed by the applicant. (Contact the SDDOT Representative noted on the permit for information regarding noxious weed and chemical application

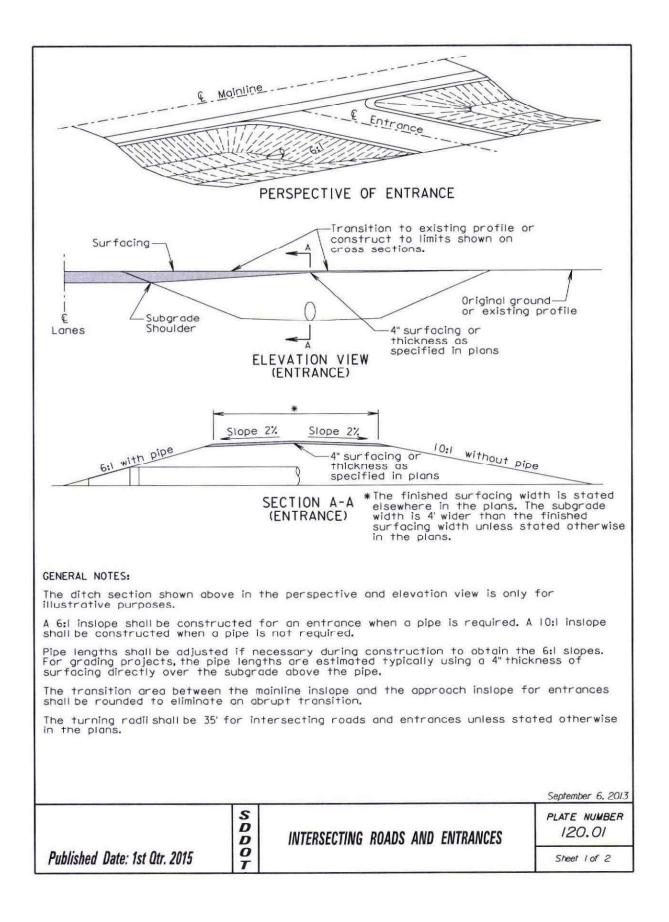

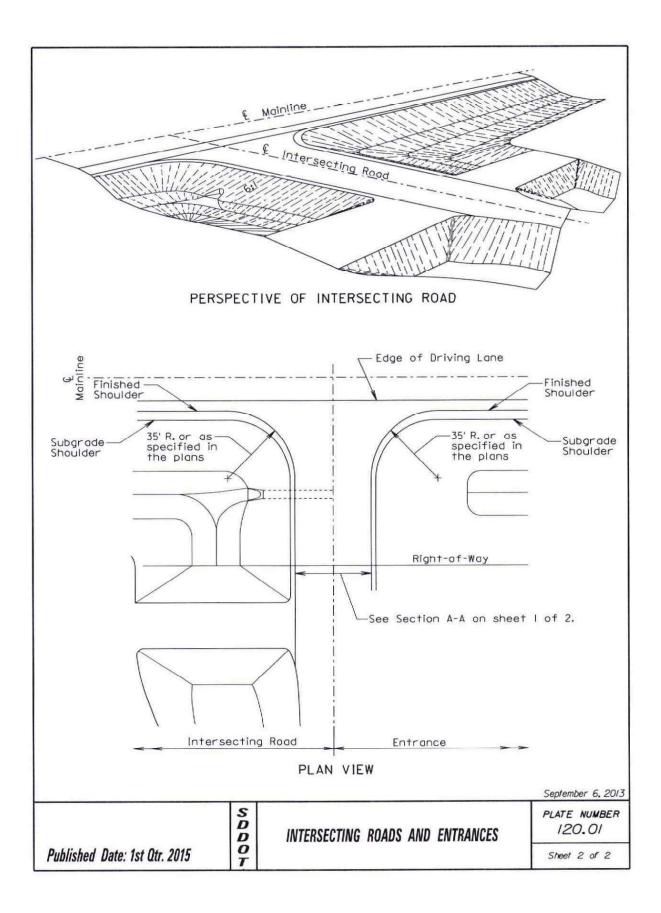


# SWEETLAND WIND PROJECT SD HIGHWAY 45 AND 205TH STREET INTERSECTION TURN RADII IMPROVEMENTS STATE MAP

3


PROJE	CT INFORMATION
LOCATION	
STATE	SOUTH DAKOTA
COUNTIES	HAND COUNTY
NEARBY CITY	MILLER
COORDINATE SYSTEM	
ZONE	SOUTH DAKOTA HARN SPC, NORTH ZONE, NAD 83
UNIT	US SURVEY FEET
ABBREVIATION	HARN/SD.SD-NF
VERTICAL DATUM	NAVD 88 (GEOID12B)
OWNER	
COMPANY	SWEETLAND WIND FARM, LLC
ADDRESS	5775 FLATIRON PARKWAY, STE 120
CITY, STATE, ZIP	BOULDER, CO 8030 <sup>7</sup>
GENERAL CONTRACTOR	
COMPANY	TBD
ADDRESS	
CITY, STATE, ZIP	
CIVIL ENGINEER OF RECORD	
COMPANY	RRC POWER & ENERGY, LLC
ADDRESS	810 HESTERS CROSSING RD STE 120
CITY, STATE, ZIP	ROUND ROCK, TX 7868
TELEPHONE	(512) 815-4876
SITE CONTACTS	
COMPANY	TBD
CONTACT #1	
TITLE	
TELEPHONE	
CONTACT #2	TBD
TITLE	
TITLE TELEPHONE	
TELEPHONE	TBD

2




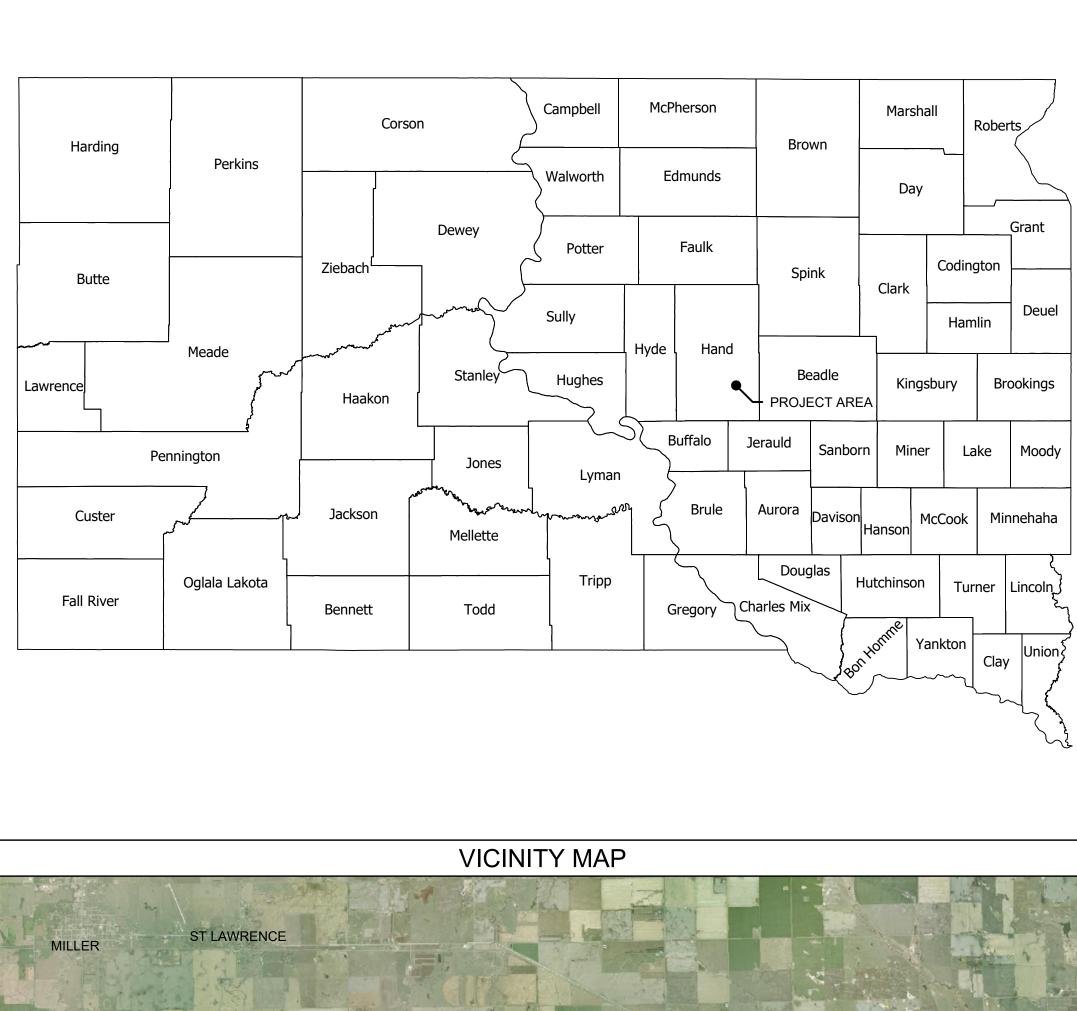


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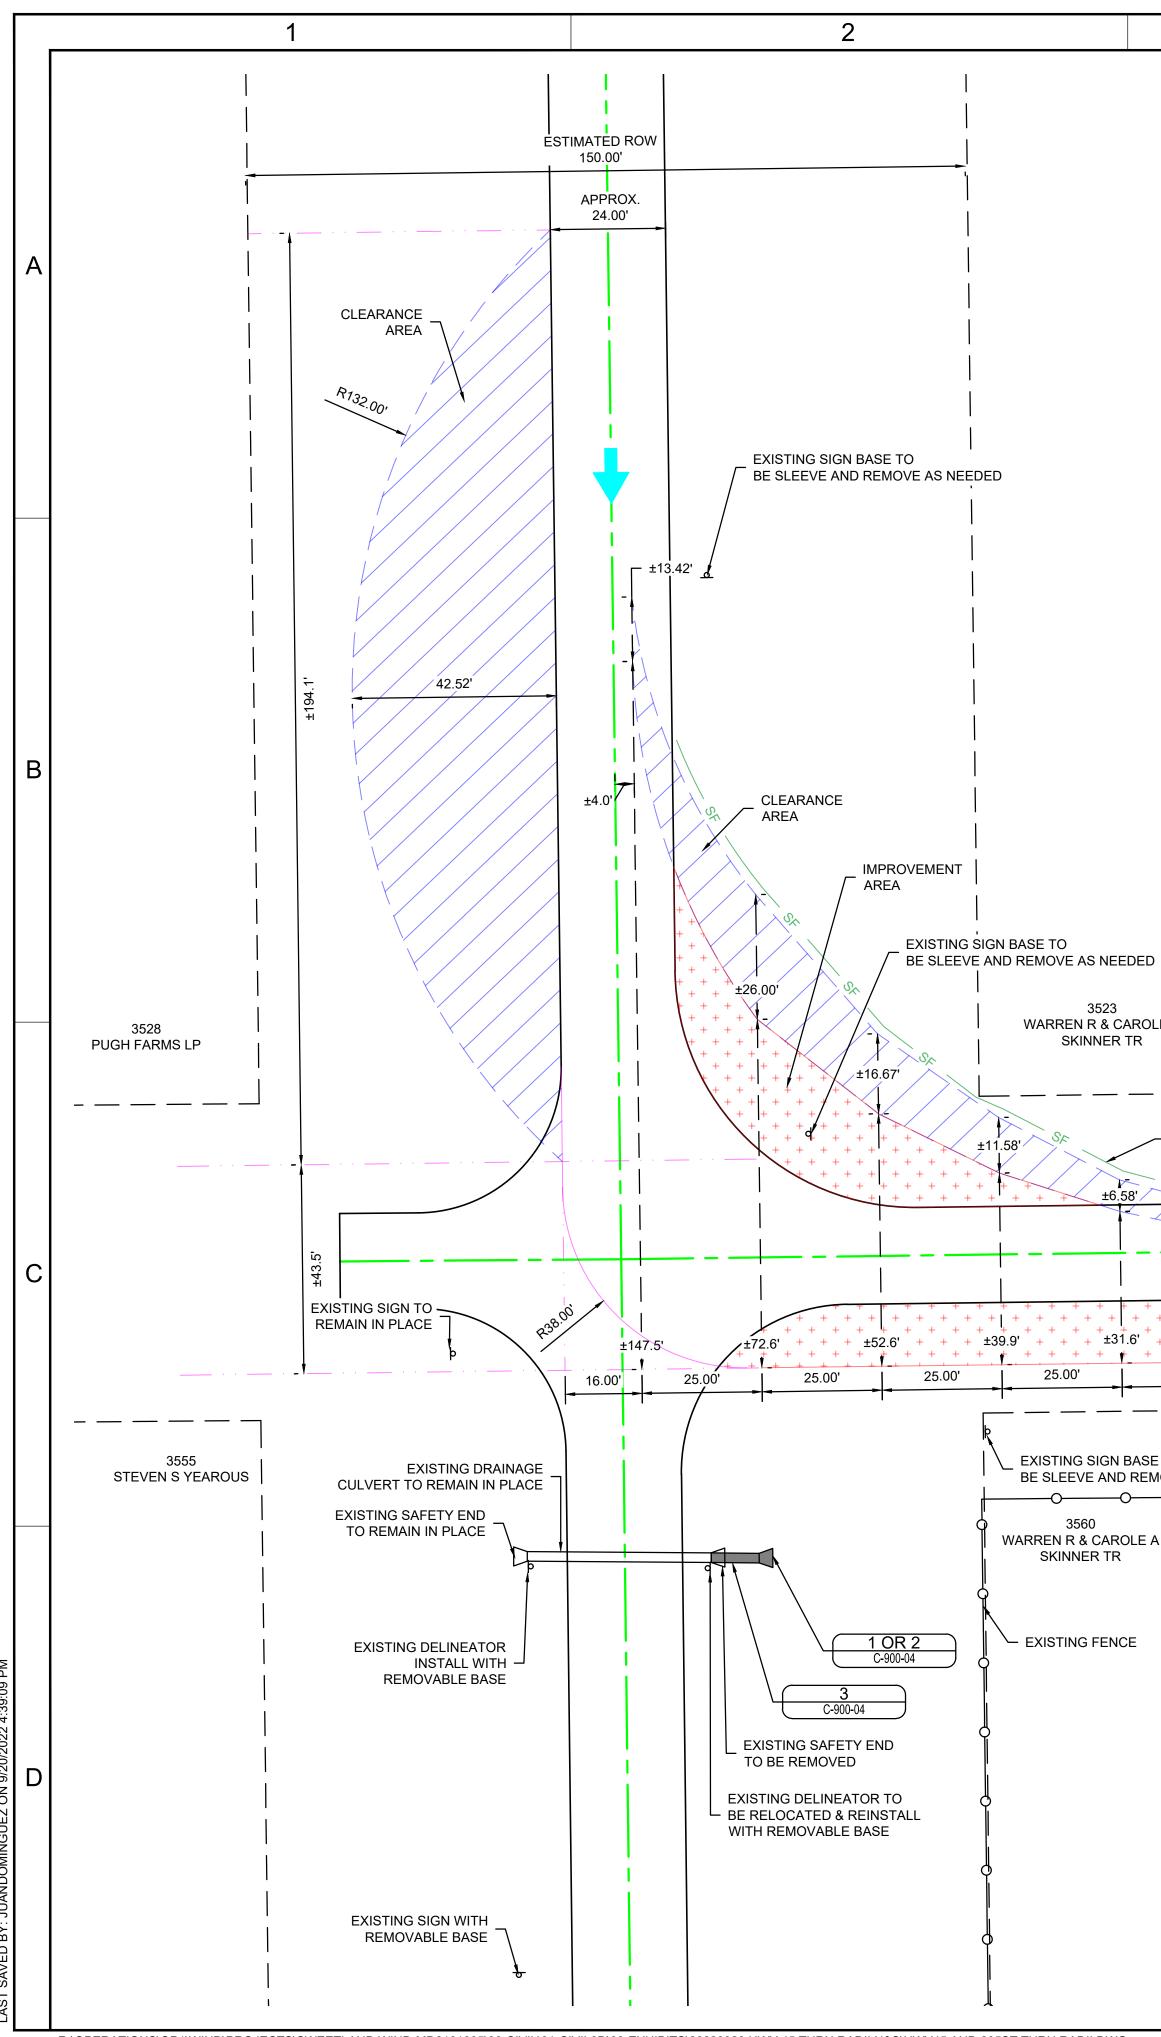


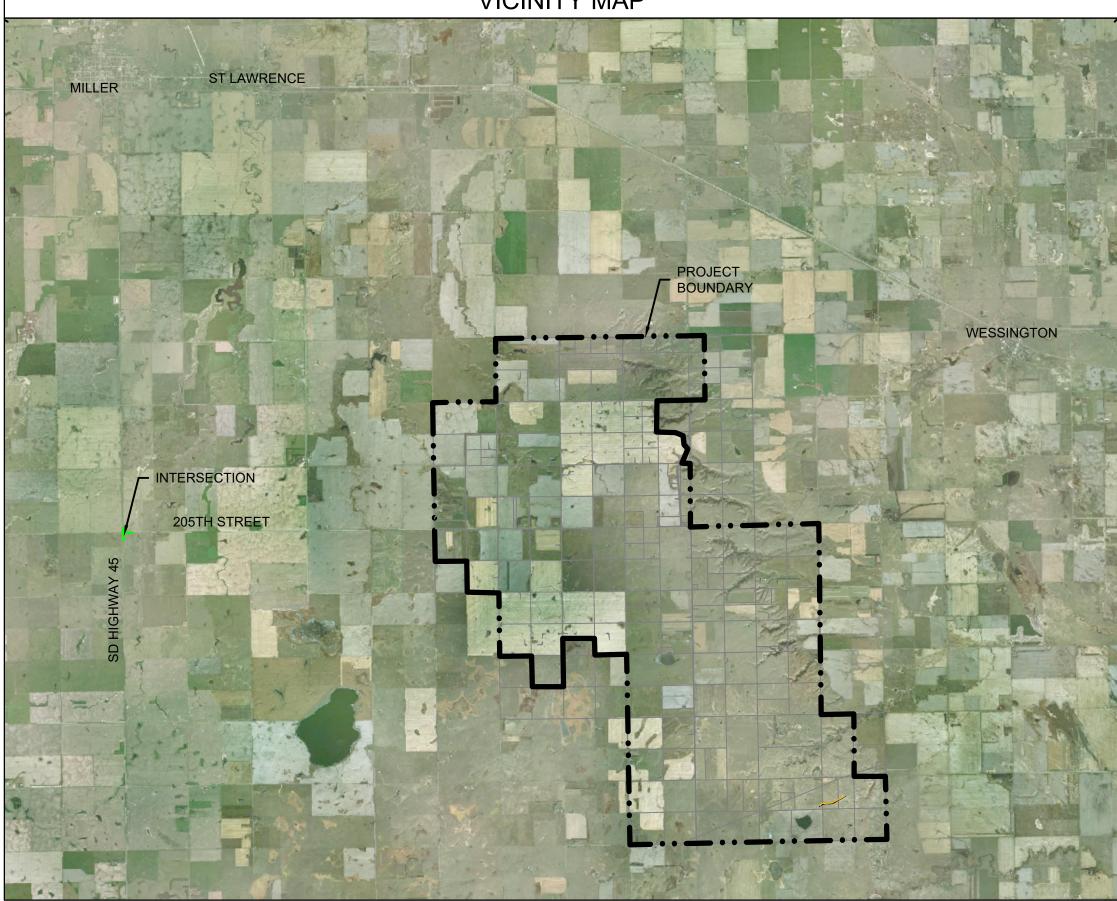CADFILE: C-000-01 COVER SHEET

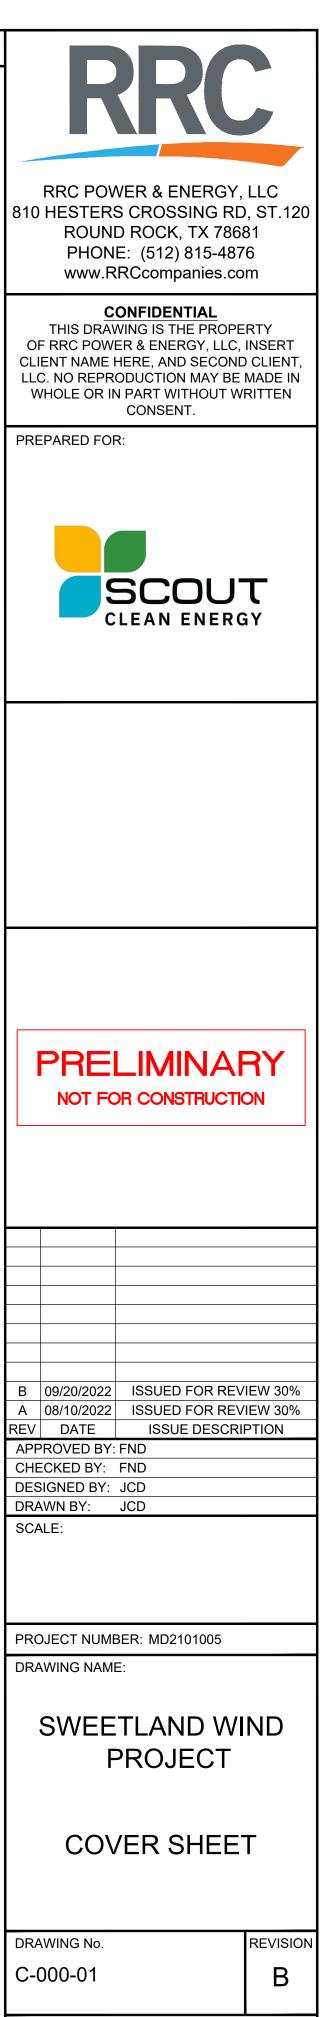

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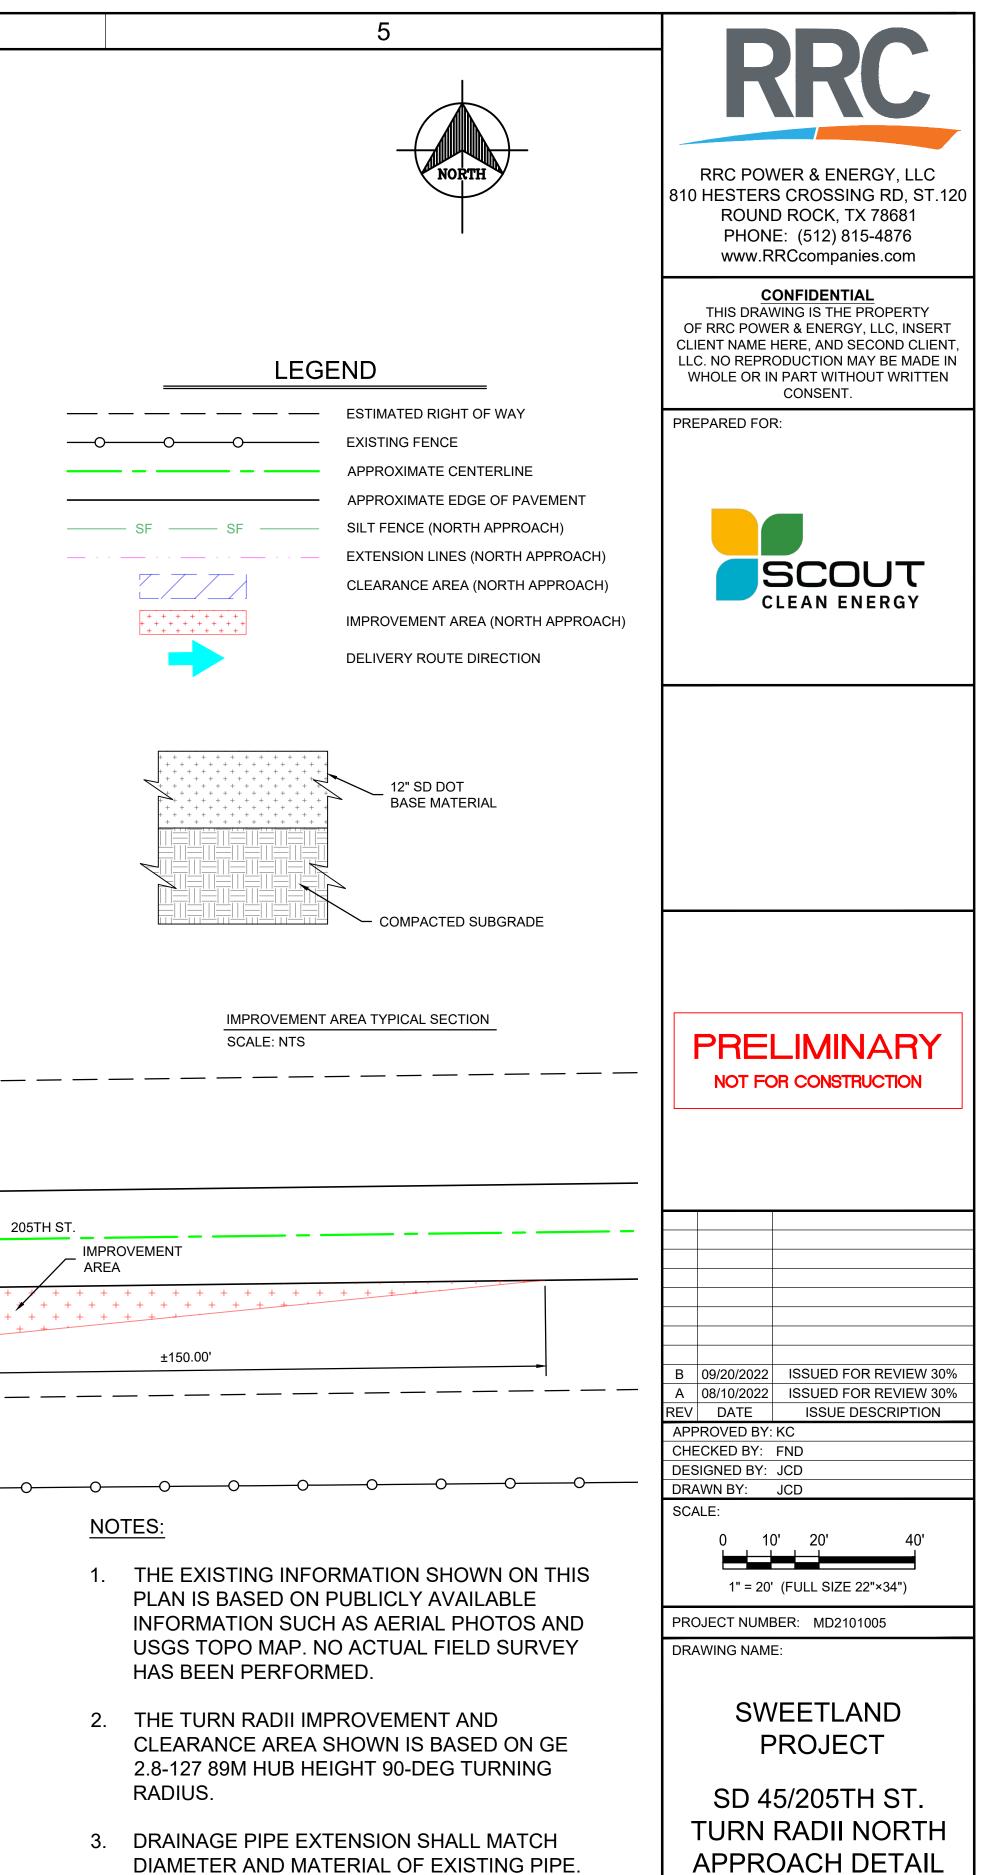


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GIGN BASE TO					 	0	 					0		0
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FENCE													1.	THE PLA INF( USC HAS
													2.	THE CLE 2.8- RAE
													3.	DRA DIAI
													4.	DRA FIEL CLE

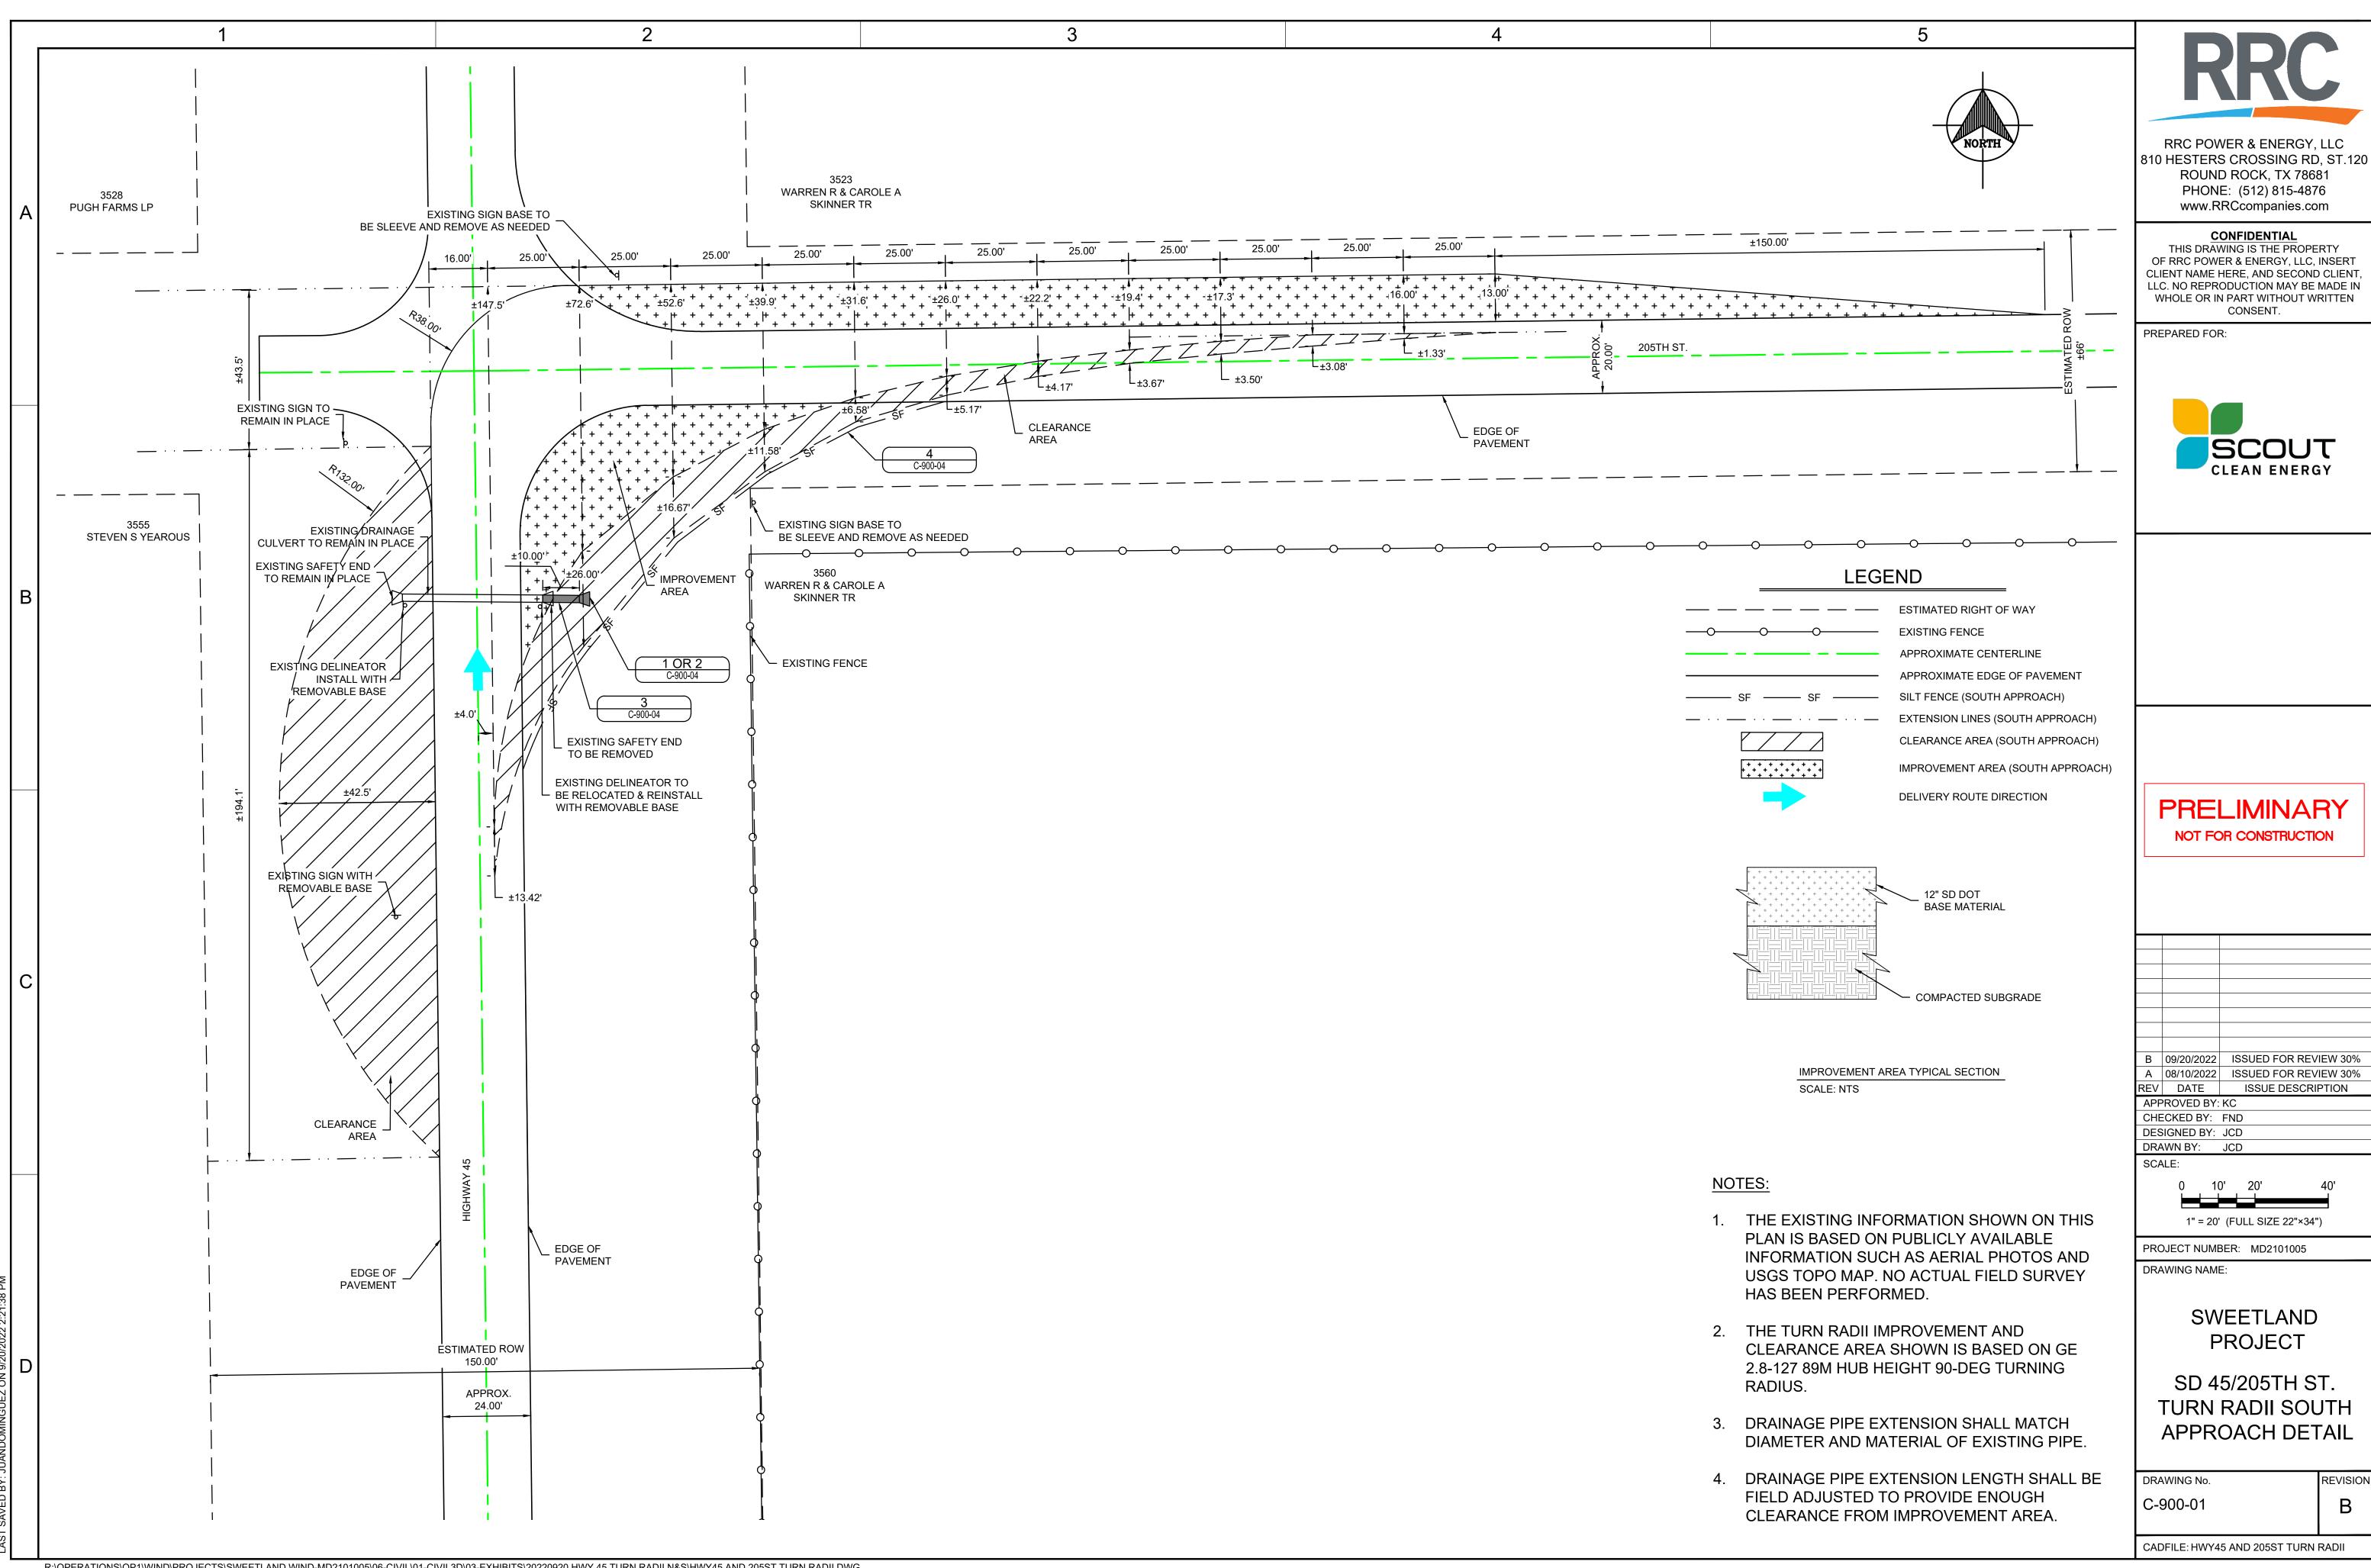EDGE OF C-900-04 ±6.58' SF \_ **⊏**±5.17' ∟±4.17 r±3.67' <u>±3.50</u> 205TH ST. ⊏±3.08' IMPROVEMENT <u>t</u> ±1.33' AREA - + + + + + + + + + + + + + + + + + + . . . . . . . . . . . + + + + + +25.00' 25.00' 25.00' 25.00' 25.00' 25.00' 25.00'

3523 WARREN R & CAROLE A SKINNER TR



RAINAGE PIPE EXTENSION LENGTH SHALL BE IELD ADJUSTED TO PROVIDE ENOUGH LEARANCE FROM IMPROVEMENT AREA.


CADFILE: HWY45 AND 205ST TURN RADII

REVISION

Α

DRAWING No.

C-900-02

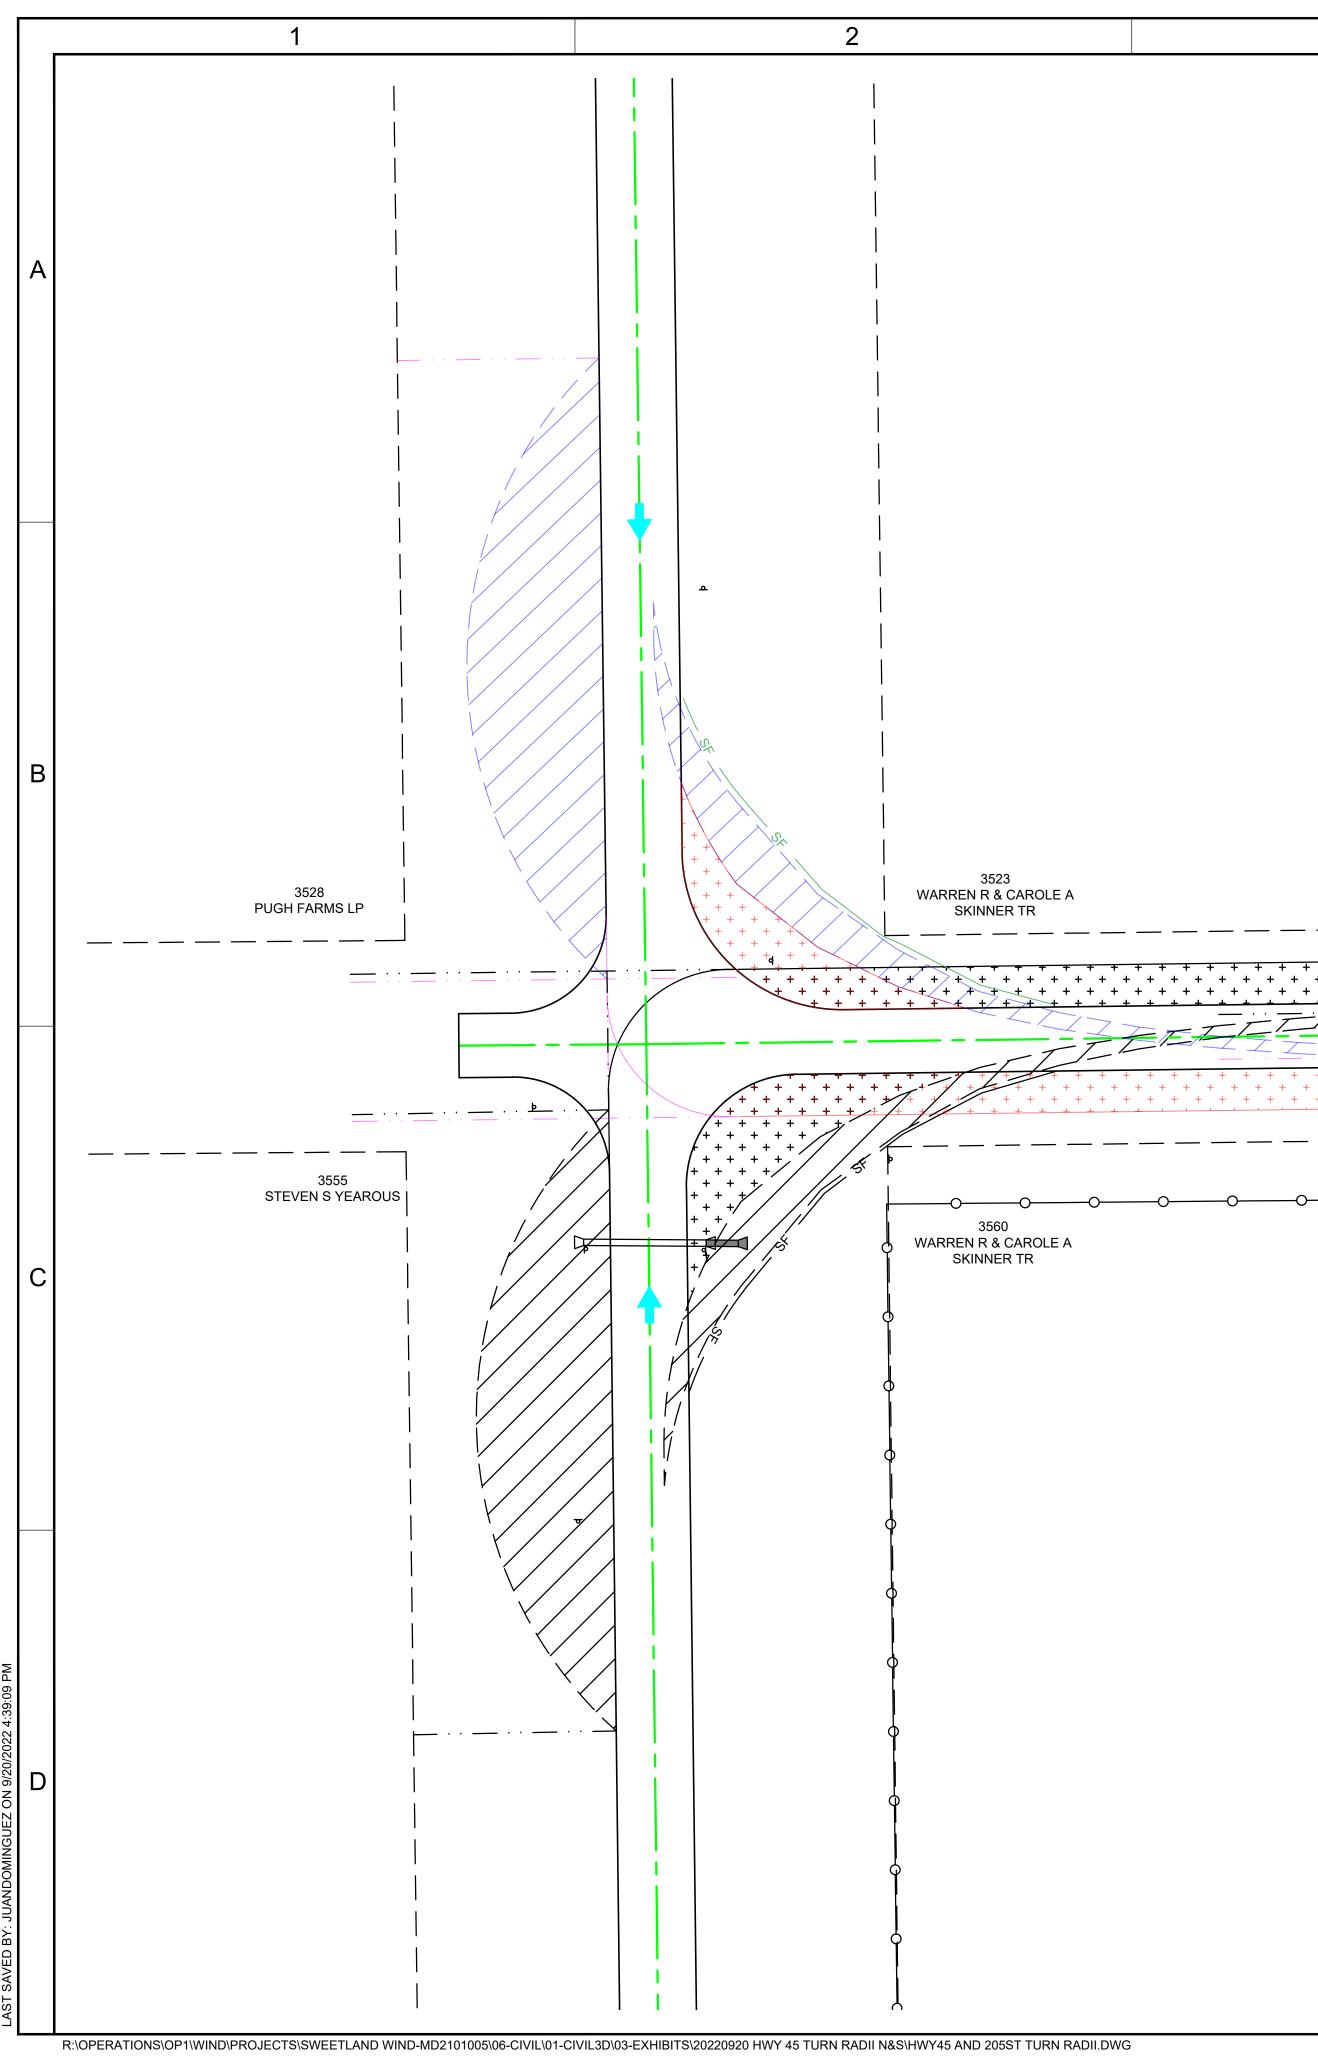

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### NOTES:

* * * * * * * * * * * * * * * * * * *	1.	THE PLA INFC USG HAS
COMPACTED SUBGRADE	2.	THE CLE 2.8-7 RAD
IMPROVEMENT AREA TYPICAL SECTION	3.	DRA DIAN
SCALE: NTS	4.	DRA FIEL



## LEGEND



APPROXIMATE CENTERLINE APPROXIMATE EDGE OF PAVEMENT SILT FENCE (SOUTH APPROACH) SILT FENCE (NORTH APPROACH) — · · · — EXTENSION LINES (SOUTH APPROACH) EXTENSION LINES (NORTH APPROACH) CLEARANCE AREA (SOUTH APPROACH) CLEARANCE AREA (NORTH APPROACH) IMPROVEMENT AREA (SOUTH APPROACH) IMPROVEMENT AREA (NORTH APPROACH) DELIVERY ROUTE DIRECTION

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RRC POWER & ENERGY, LLC 810 HESTERS CROSSING RD, ST.120 ROUND ROCK, TX 78681 PHONE: (512) 815-4876 www.RRCcompanies.com

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PREPARED FOR:



## PRELIMINARY NOT FOR CONSTRUCTION

В	09/20/2022	<b>ISSUED FOR REVIEW 30%</b>						
А	08/10/2022	<b>ISSUED FOR REVIEW 30%</b>						
REV	DATE	ISSUE DESCRIPTION						
APF	PROVED BY:	КС						
CHE	CKED BY:	FND						
DES	GNED BY:	JCD						
DRA	WN BY:	JCD						
SCA	ALE:							
	0 1	5' 30' 60'						
	1" = 30' (FULL SIZE 22"×34")							
PRC	PROJECT NUMBER: MD2101005							
DRA	WING NAM	E:						

SWEETLAND
PROJECT
SD 45/205TH ST.
<b>TURN RADII NORTH &amp;</b>
SOUTH APPROACH
COMBINED DETAIL

DRAWING No. C-900-03


**HE EXISTING INFORMATION SHOWN ON THIS** AN IS BASED ON PUBLICLY AVAILABLE FORMATION SUCH AS AERIAL PHOTOS AND SGS TOPO MAP. NO ACTUAL FIELD SURVEY AS BEEN PERFORMED.

IE TURN RADII IMPROVEMENT AND EARANCE AREA SHOWN IS BASED ON GE 3-127 89M HUB HEIGHT 90-DEG TURNING DIUS.

RAINAGE PIPE EXTENSION SHALL MATCH AMETER AND MATERIAL OF EXISTING PIPE.

RAINAGE PIPE EXTENSION LENGTH SHALL BE ELD ADJUSTED TO PROVIDE ENOUGH CLEARANCE FROM IMPROVEMENT AREA.

CADFILE: HWY45 AND 205ST TURN RADII

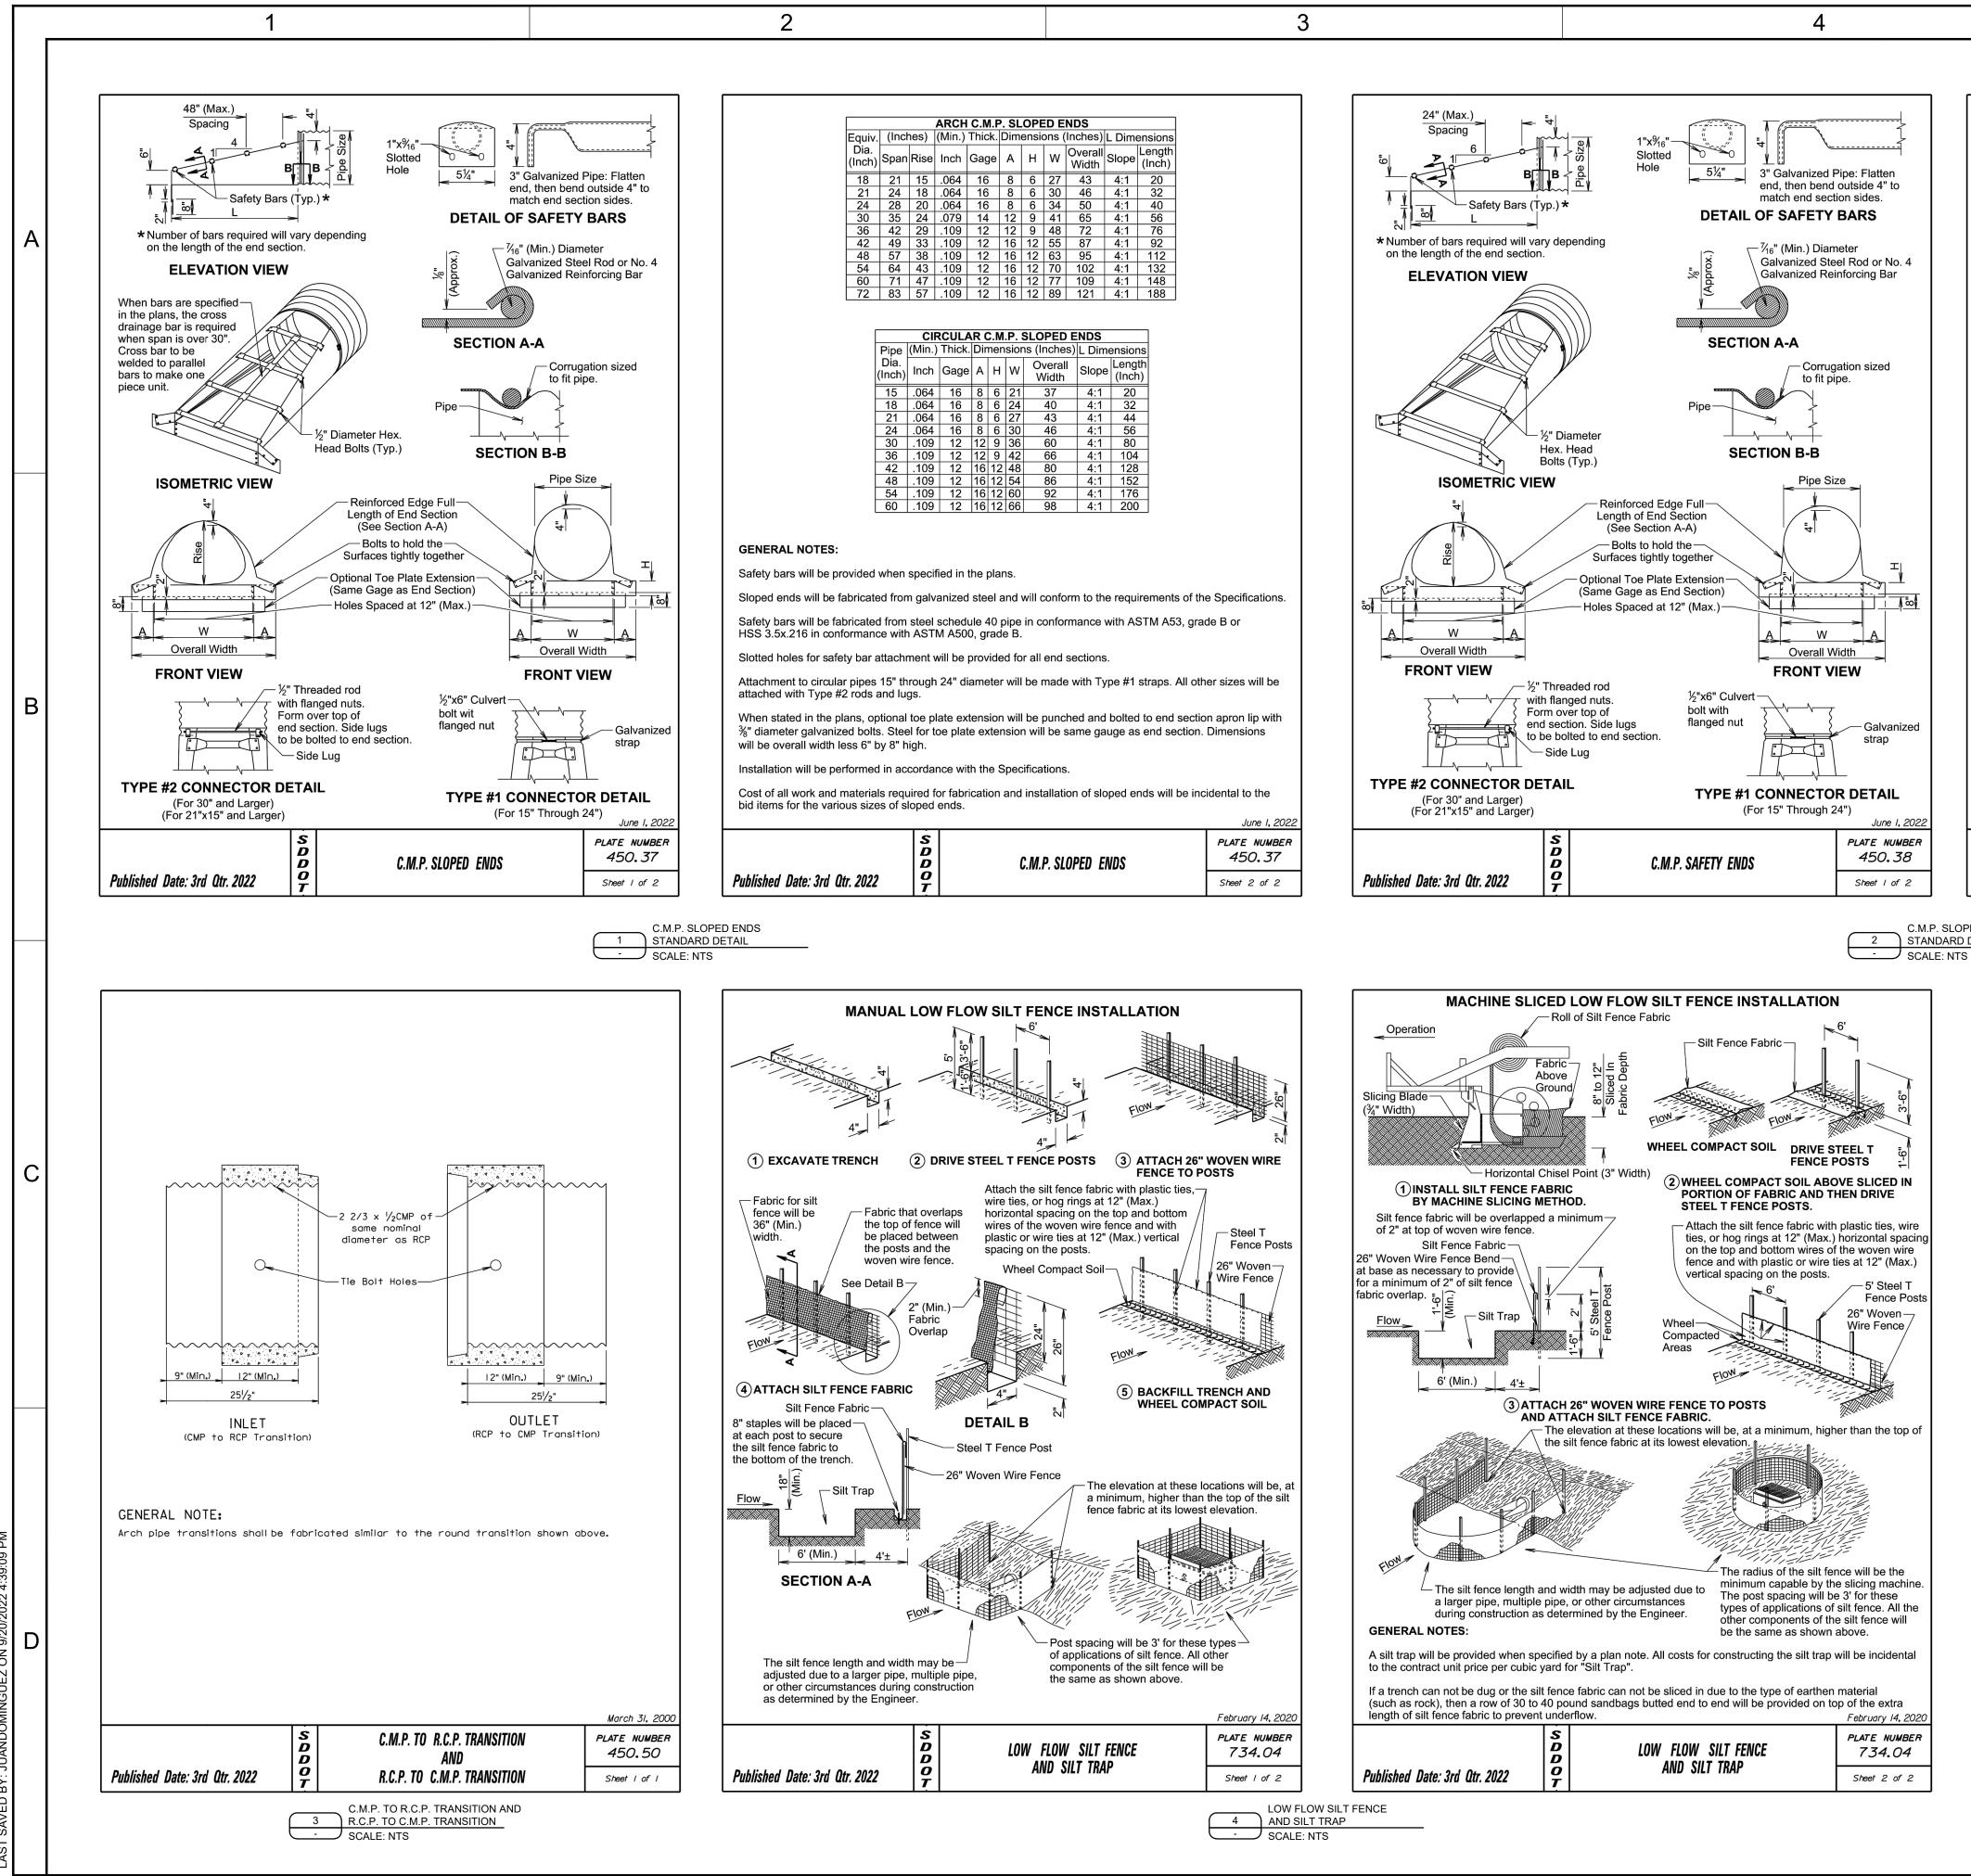


R:\OPERATIONS\OP1\WIND\PROJECTS\SWEETLAND WIND-MD2101005\06-CIVIL\01-CIVIL3D\03-EXHIBITS\20220920 HWY 45 TURN RADII N&S\HWY45 AND 205ST TURN RADII.DWG



P. (	P. SLOPED ENDS							
ions (Inches) L Dimensions								
N	Overall Width	Slope	Length (Inch)					
21 24	37	4:1	20					
24	40	4:1	32					
27	43	4:1	44					
30	46	4:1	56					
36	60	4:1	80					
12	66	4:1	104					
18	80	4:1	128					
54	86	4:1	152					
60	92	4:1	176					
66	98	4:1	200					

SL	SLOPED ENDS							
imensions (Inches) L Dimensions								
٩	н	W	Overall Width	Slope	Length (Inch)			
3	6	27	43	4:1	20			
3	6	30	46	4:1	32			
3 3 2 2 6	6	34	50	4:1	40			
2	9	41	65	4:1	56			
2	9	48	72	4:1	76			
6	12	55	87	4:1	92			
6	12	63	95	4:1	112			
6	12	70	102	4:1	132			
6	12	77	109	4:1	148			
6	12	89	121	4:1	188			

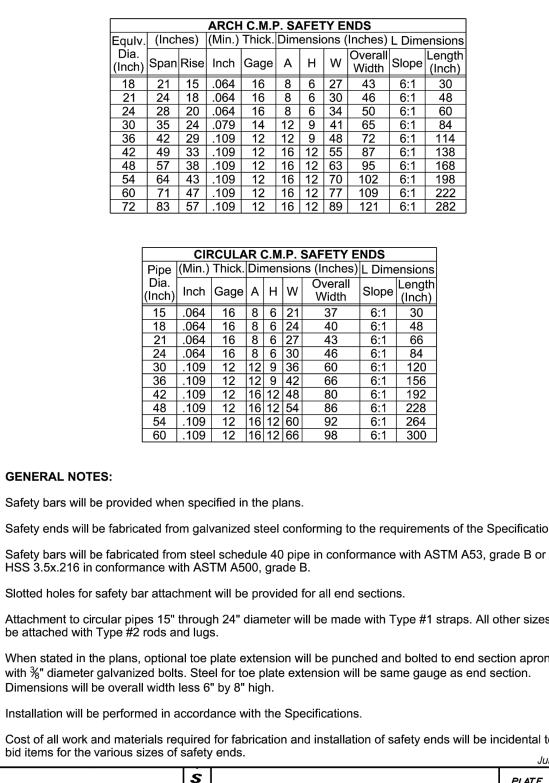

Published Date: 3rd Qtr. 2022

C.M.P. SLOPED ENDS STANDARD DETAIL SCALE: NTS

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		ARCH	I C.M.F	P. SA	<b>\FET</b>	YE	NDS		
(Incl	ıes)	(Min.)	Thick.	Dim	ensio	ons (	Inches)	L Dime	ension
Span	Rise	Inch	Gage	А	н	W	Overall Width	Slope	Lengtl (Inch)
21	15	.064	16	8	6	27	43	6:1	30
24	18	.064	16	8	6	30	46	6:1	48
28	20	.064	16	8	6	34	50	6:1	60
35	24	.079	14	12	9	41	65	6:1	84
42	29	.109	12	12	9	48	72	6:1	114
49	33	.109	12	16	12	55	87	6:1	138
57	38	.109	12	16	12	63	95	6:1	168
64	43	.109	12	16	12	70	102	6:1	198
71	17	100	12	16	12	77	100	6.1	222

CIRCULAR C.M.P. SAFETY ENDS								
Pipe	(Min.)	Thick.	Dir	nen	sior	ns (Inches)	L Dime	ensions
Dia. (Inch)	Inch	Gage	А	н	w	Overall Width	Slope	Length (Inch)
15	.064	16	8	6	21	37	6:1	30
18	.064	16	8	6	24	40	6:1	48
21	.064	16	8	6	27	43	6:1	66
24	.064	16	8	6	30	46	6:1	84
30	.109	12	12	9	36	60	6:1	120
36	.109	12	12	9	42	66	6:1	156
42	.109	12	16	12	48	80	6:1	192
48	.109	12	16	12	54	86	6:1	228
54	.109	12	16	12	60	92	6:1	264
60	.109	12	16	12	66	98	6:1	300

Safety bars will be provided when specified in the plans.

Safety ends will be fabricated from galvanized steel conforming to the requirements of the Specifications.

HSS 3.5x.216 in conformance with ASTM A500, grade B.

Slotted holes for safety bar attachment will be provided for all end sections.

Attachment to circular pipes 15" through 24" diameter will be made with Type #1 straps. All other sizes will

When stated in the plans, optional toe plate extension will be punched and bolted to end section apron lip with  $\frac{3}{3}$ " diameter galvanized bolts. Steel for toe plate extension will be same gauge as end section.

Installation will be performed in accordance with the Specifications.

Cost of all work and materials required for fabrication and installation of safety ends will be incidental to the

	<b>y</b>	June 1, 2022
S D D	C.M.P. SAFETY ENDS	plate number 450.38
		Sheet 2 of 2



**RRC POWER & ENERGY, LLC** 810 HESTERS CROSSING RD, ST.120 ROUND ROCK, TX 78681 PHONE: (512) 815-4876 www.RRCcompanies.com

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PREPARED FOR:



# PRELIMINARY

NOT FOR CONSTRUCTION

В	09/20/2022	<b>ISSUED FOR REVIEW 30%</b>
Α	08/10/2022	<b>ISSUED FOR REVIEW 30%</b>
REV	DATE	ISSUE DESCRIPTION
APF	ROVED BY:	КС
CHE	CKED BY:	FND
DES	GNED BY:	JCD
DRA	WN BY:	JCD
SCA	LE:	

PROJECT NUMBER: MD2101005

DRAWING NAME:

SWEETLAND PROJECT
SD 45/205TH ST.

### TURN RADII STANDARD DETAILS

DRAWING No. C-900-04

CADFILE: HWY45 AND 205ST TURN RADII